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D

C



B

A

1

PLUMBING - SUPPLY & DRAINAGE PLAN - FOUNDATION - AREA A

1/8" = 1'-0"

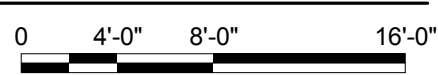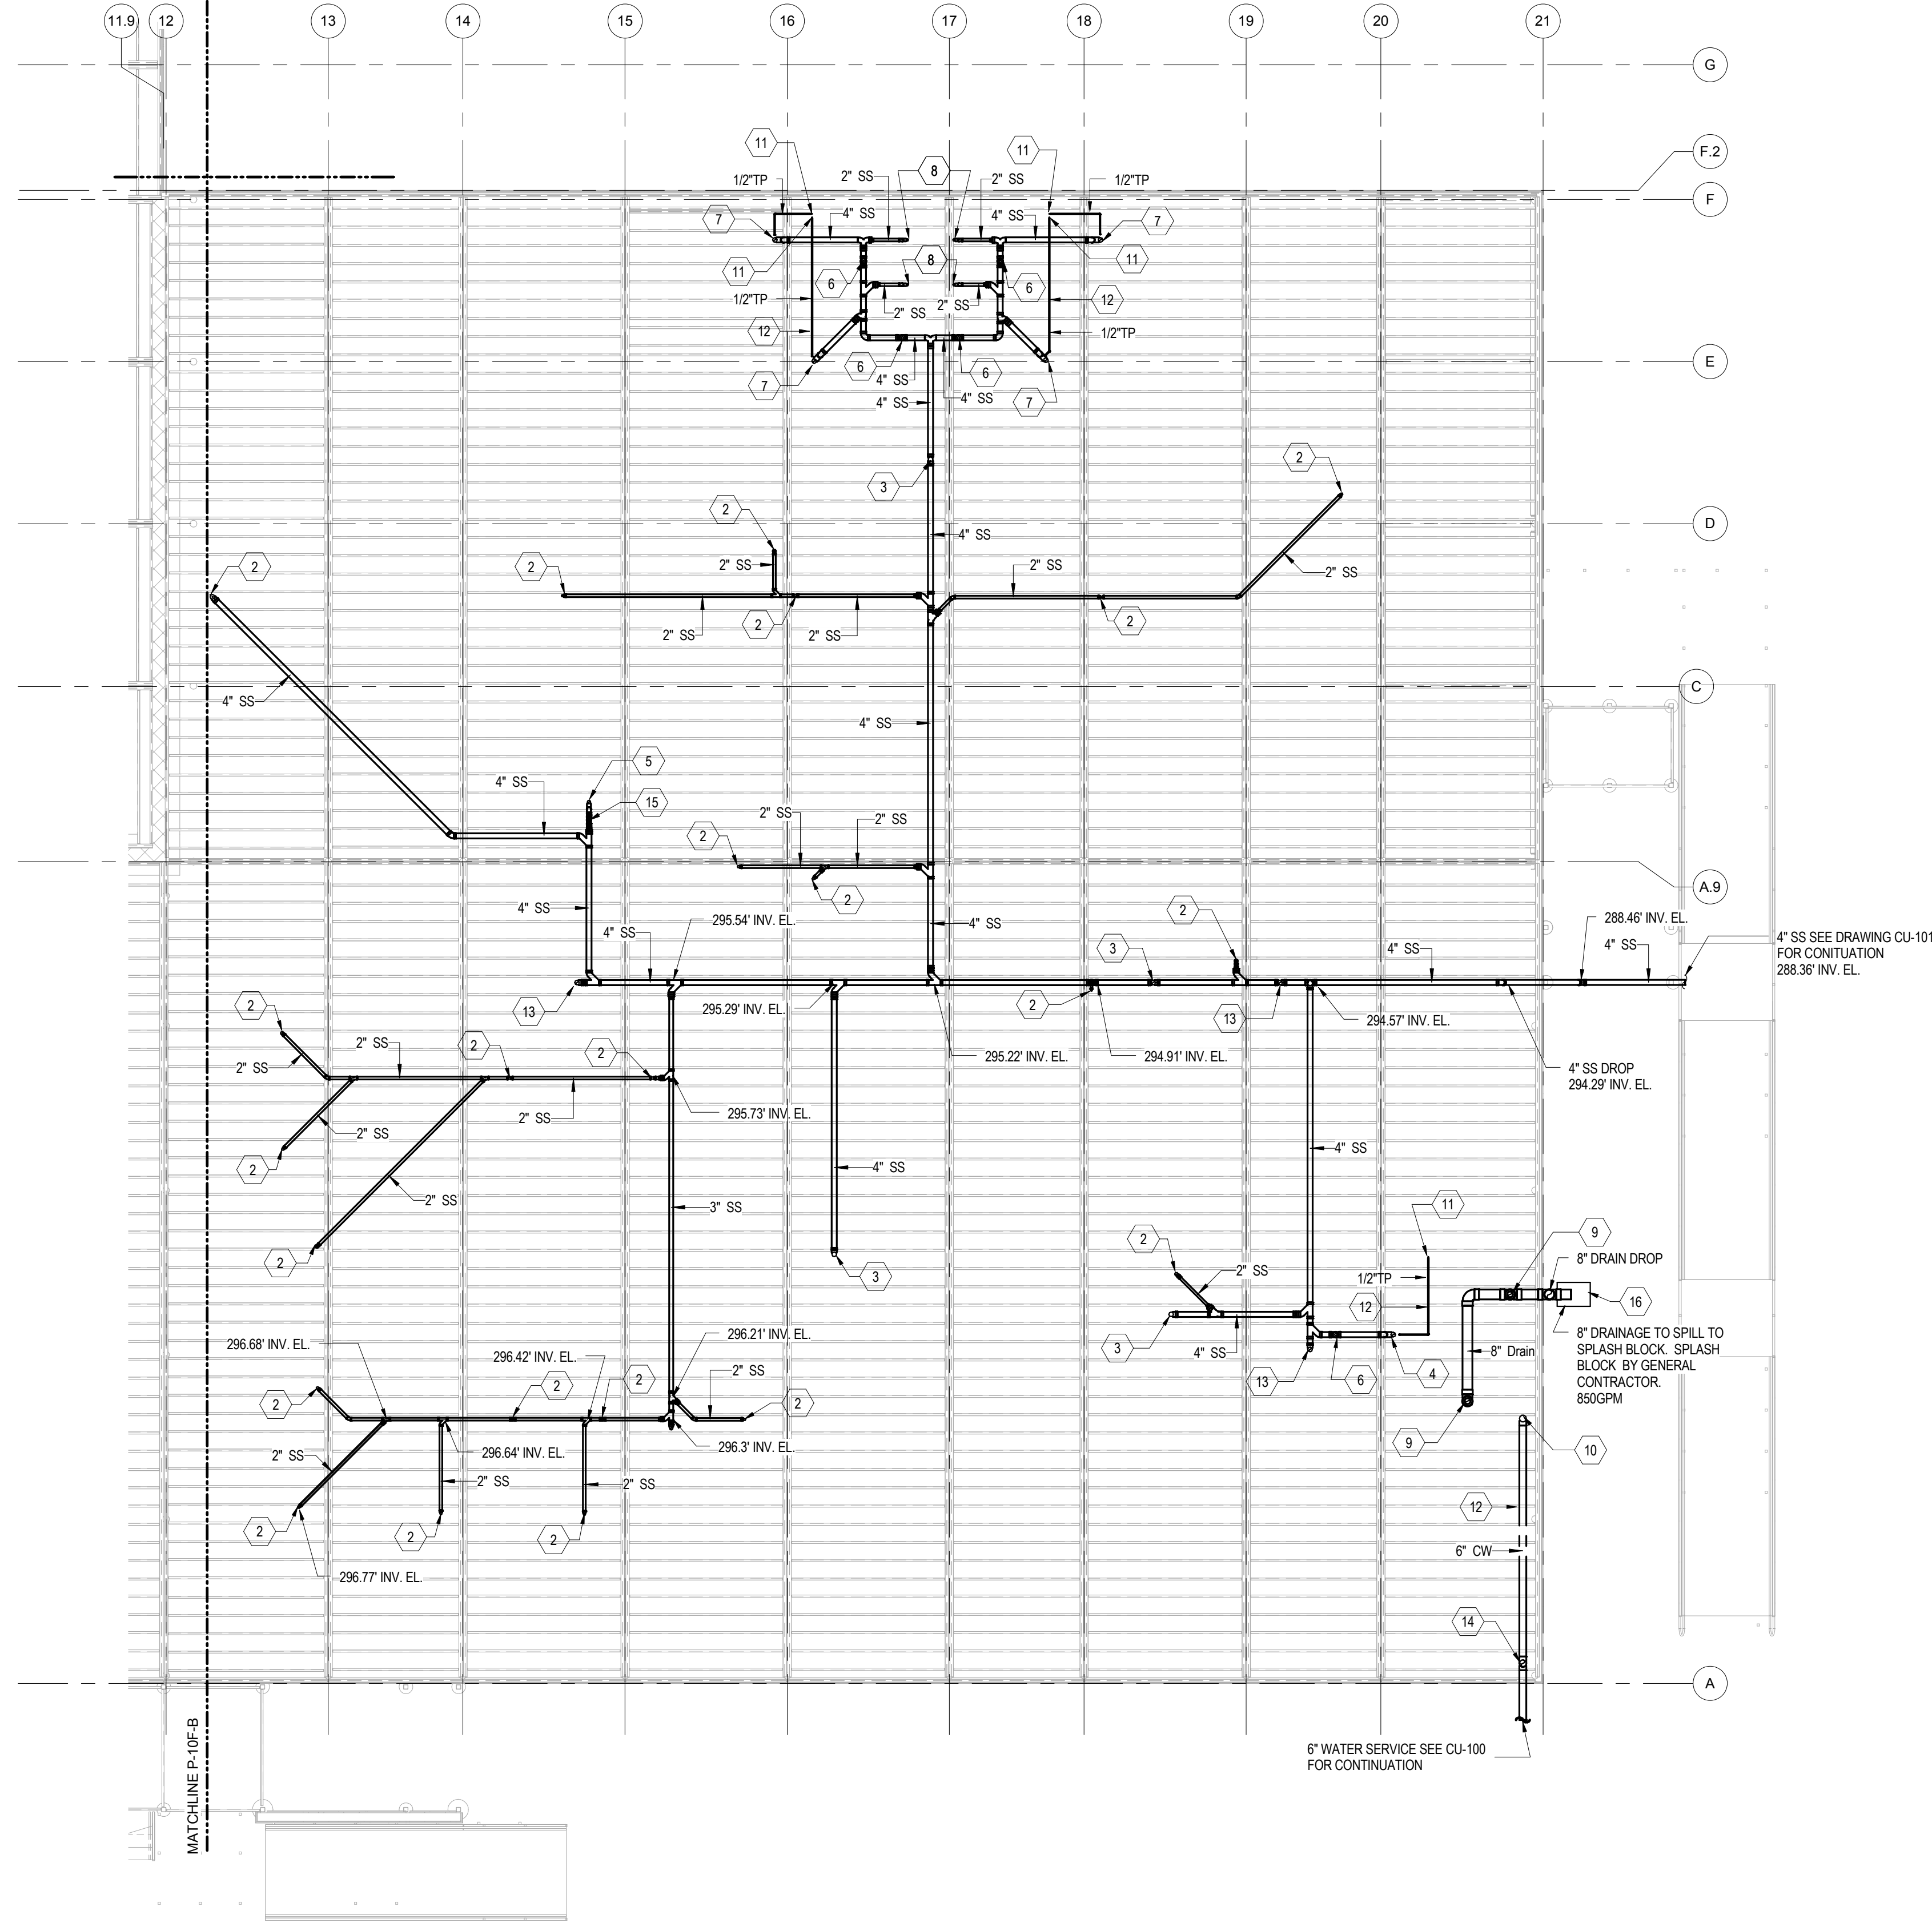


GENERAL NOTES:


- ALL PIPING LOCATED IN THE UNHEATED CRAWL SPACE SHALL BE INSULATED.
- ALL P-TRAPS IN THE UNHEATED CRAWL SPACE SHALL BE INSULATED AND HEAT TRACED.
- ALL EXPOSED WATER PIPING IN UNHEATED CRAWLSPACE SHALL BE INSULATED AND HEAT TRACED.
- ALL DRAIN PIPING TO BE SLOPED AT 1/4" PER FOOT

KEYED NOTES:


- 1 1/2" SS FROM ABOVE
- 2" SS FROM ABOVE
- 4" SS FROM ABOVE
- 4" SS FROM FS ABOVE; PROVIDE 5 WATTS LF HEAT TRACING CABLE TO SANITARY P-TRAPS IN UNHEATED CRAWL SPACE. TYPICAL. REFER TO SPECIFICATION 23 05 15 FOR HEAT TRACE CABLE.
- 3" SS FROM MS ABOVE; PROVIDE 5 WATTS LF HEAT TRACING CABLE TO SANITARY P-TRAPS IN UNHEATED CRAWL SPACE. TYPICAL. REFER TO SPECIFICATION 23 05 15 FOR HEAT TRACE CABLE.
- 2" VENT UP
- 4" SS FROM FD ABOVE; PROVIDE 5 WATTS LF HEAT TRACING CABLE TO SANITARY P-TRAPS IN UNHEATED CRAWL SPACE. TYPICAL. REFER TO SPECIFICATION 23 05 15 FOR HEAT TRACE CABLE.
- 2" SS FROM SH ABOVE; PROVIDE 8 WATTS LF HEAT TRACING CABLE TO SANITARY P-TRAPS IN UNHEATED CRAWL SPACE. TYPICAL. REFER TO SPECIFICATION 23 05 15 FOR HEAT TRACING CABLE.
- 8" DRAINAGE FROM ABOVE
- 6" DOMESTIC WATER SUPPLY UP
- 1/2" TP FROM ABOVE
- PROVIDE 5 WATTS LF HEAT TRACING CABLE ON ALL EXPOSED DOMESTIC WATER, FIRE, & TRAP PRIMER PIPING IN UNHEATED CRAWL SPACE. TYPICAL. REFER TO SPECIFICATION 23 05 15 FOR HEAT TRACING CABLE.
- 4" SS FROM CO ABOVE
- 6" CW RISE
- 1 1/2" VENT UP
- PROVIDE RODENT SCREEN ON END OF DRAIN LINE.

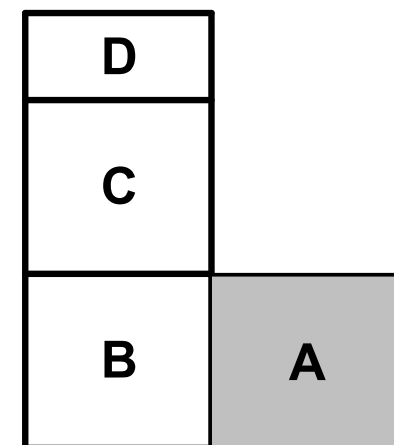

KEY PLAN

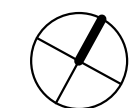

	FINAL CORRECTED SET	03/26/14
	100% FINAL DESIGN SUBMISSION	02/14/14
	65% V.E. SUBMISSION	11/25/13
	65% SUBMITTAL	04/26/13
	35% SUBMITTAL	03/08/13
SYM	DESCRIPTION	DATE

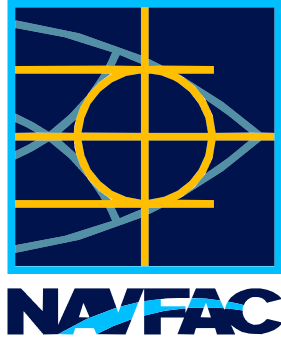

HDR
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APPROVED	
FOR COMMANDER NAVFAC	
ACTIVITY	
SATISFACTORY TO DATE	
DES	CBH
DRW	CBH
CHK	AB
PM/CM	CHEMENJU/HILL
BRANCH MANAGER	N/A
CHIEF ENGINEER	TOM COX

NAVAL FACILITIES ENGINEERING COMMAND	NAVAL FACILITIES ENGINEERING COMMAND
COMPONENT NAME	NAVAL FACILITIES ENGINEERING COMMAND ~ AGENCY
PROJECT STATION/INSTALLATION	BASE - CITY, STATE
P125 - TEMPORARY MEDICAL FACILITIES	BETHESDA, MD
PACKAGE 2 - CLINIC BUILDING	
PLUMBING - SUPPLY AND DRAINAGE PLAN - FOUNDATION - AREA A	

SCALE	1/8" = 1'-0"
PROJECT NO.	1151333
CONSTR. CONTR. NO.	N62470-09-D-9044
NAVFAC DRAWING NO.	13065980
SHEET	OF 0
P-10F-A	